



Environmental Programs Division

Office 405 - 521-3050

Programmatic/Individual Categorical Exclusion

	PCE	X	ICE
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Date	May 21, 2020	Project Number	J3-0425(004); J3-0425(007)
County	Grady	State Job Piece No:	30425(04); 30425(07)
NEPA Project Manager	Greg Worrell	Phone Number	405-522-8014
ODOT Field Division	7	Bridge NBI No. (<i>For County & State Projects</i>) & Location No. (<i>County Projects Only</i>)	08712, 08714, 09046, 09048, 11070, 11089, 11119
Project Description from JPINFO	Grade, Drain, Bridge, & Surface: SH-19 from approximately 5 miles east of US-81, extending approximately 8.5 miles to Roaring Creek Bridge		
This project is included in: <i>(Check all applicable ones)</i>		<input checked="" type="checkbox"/> State 8 Year Construction Program	
		<input checked="" type="checkbox"/> County 5 Year Construction Program	
		<input checked="" type="checkbox"/> State Transportation Improvement Program	
This project is in the Metropolitan Transportation Improvement Program (If applicable) <i>(Check applicable one)</i>		YES	
		<input checked="" type="checkbox"/> NOT APPLICABLE	

The Oklahoma Department of Transportation (ODOT) has completed the environmental analysis and review of the referenced project. ODOT has determined that this project does not individually or cumulatively have a significant impact of the environment as defined by the National Environmental Policy Act (NEPA) or involve unusual circumstances as defined in 23 CFR 771.117(b) and is therefore excluded from the requirements to prepare an Environmental Assessment or Environmental Impact Assessment.

Existing Conditions *(Describe existing bridge width, approach roadway width, etc., traffic (current and projected), Existing Problems such as sufficiency rating):*

SH-19 from west of the Town of Alex extending to east of Alex consists of two 12-ft. wide driving lanes with 1-ft. wide paved shoulders, numerous substandard vertical curves, and inadequate clear zone. There are six (6) bridges within the extents of this project, three (3) of which are 30-ft. long reinforced concrete boxes (RCB), one (1) of which is a 38-ft. long RCB, and two (2) of which are 28-ft. wide span bridges. All bridges have approaching roadway widths of 26 ft.

The current annual average daily traffic (AADT) volume is 2,800 vehicles per day (vpd) and the projected AADT for the design year 2037 is approximately 3,800 vpd. The western segment of SH-19, which begins 5 miles east of US-81, extends 3.8 miles east, and ends west of the Town of Alex, has a collision rate of 123.69 collisions per 100 million vehicle miles, which is 1.5 times the statewide rate for similar facilities. This elevated collision rate may be attributed to inadequate paved shoulder widths, lack of clear recovery area, and inadequate sight-distance caused by substandard vertical alignments. The eastern segment of SH-19, which extends east 4.7 miles from the western segment, has a collision rate about equal to the statewide rate for similar facilities.

Purpose & Need (*Why the project is needed such as structural deficiency or bridge does not meet current state/federal standards for width or vertical clearance or the roadway has sharp horizontal curves or sight distance problems or narrow shoulders which do not meet current standards*):

The purpose of the project is to improve the safety of a facility with substandard vertical alignments, inadequate recovery clear zone, narrow bridges, and narrow shoulders such that the facility meets current design standards.

Alternatives considered & Proposed Improvement (*Provide reason why an offset alignment to one side is selected vs the other side, Proposed construction such as roadway and bridge widths, AND mention whether the road will be open to traffic during construction*):

The project consists of three segments: Segment A, which begins 5 miles east of US-81 and extends east 5.9 miles to the western limits of the Town of Alex; Segment B, consisting of approximately 0.8 mile through the Town of Alex; and Segment C, which begins east of the Town of Alex and extends east 1.8 miles to the Roaring Creek Bridge. The proposed improvements to State Highway 19 include correction of the substandard vertical alignment, adding shoulders, establishing an adequate clear zone, and addition of turn lanes at the Cedar Hills Road intersection and through the Town of Alex.

Three alternatives were considered for Segment A: (1) improvements on the existing alignment, (2) offset alignment to the north, and (3) offset alignment to the south.

Three alternatives were considered for Segment B: (1) curb and gutter section widened about the centerline, (2) an open section widened to the south with 4-ft. wide paved shoulders, and (3) an open section widened to the south with 8-ft. wide paved shoulders. All three Segment B alternatives also included a middle left turn lane.

Three alternatives were considered for Segment C: (1) improvements on the existing alignment, (2) offset alignment to the north, and (3) offset alignment to the south.

At a public Open House held June 29, 2017 ODOT presented the Preferred Alternative for improvement of three segments of SH-19 and requested public comment. The Preferred Alternative presented at the Open House was:

- Segment A: Alternative 2 – North Offset
- Segment B: Alternative 2 – Open Section with 4-foot shoulders
- Segment C: Alternative 1 – Improvements on existing alignment

Subsequent to the Open House, ODOT received public comments, including questions about anticipated impacts to private property, suggestions for an alternative improvement to NS 294 (Cemetery Road), support for Segment A: Alternative 2 - North Offset, and additional information regarding underground oil utility locations. ODOT also met with representatives of the Southern Plains Landfill to discuss potential landfill impacts associated with the Segment A Preferred Alternative, i.e., Alternative 2 - North Offset. The Alternative 2 - North Offset would require acquisition of approximately 10 acres of right-of-way from the landfill's proposed expansion, resulting in the total estimated cost of Alternative 2 - North Offset being \$11.7 million greater than that of Alternative 3 - South Offset. Due to the estimated economic impacts of Alternative 2 - North Offset, ODOT revised the Preferred Alternative for Segment A from Alternative 2 - North Offset to Alternative 3 - South Offset. The public was informed of this change in a public flyer mailed March 9, 2018 to all agencies and interested parties on the project mailing list. There was no public comment period associated with the flyer; rather, the flyer provided the public a link to ODOT's website, where the public flyer and all associated public involvement materials would be available for review.

Therefore, the final Preferred Alternative is:

- Segment A: Alternative 3 – South Offset, improvements offset 65 ft. south of the existing centerline, and the realignment of all section line road intersections to replace skewed intersections with perpendicular intersection, thereby improving sight-distance.
- Segment B: Alternative 2 – Open Section with 4-ft. shoulders, and the realignment of all section and non-section line road intersections to replace skewed intersections with perpendicular intersections, thereby improving sight-distance.
- Segment C: Alternative 1 – Improvements on existing alignment, to include pavement resurfacing, rehabilitation and/or restoration, shoulder widening, flattening substandard vertical curves, roadside clear zone adjustment, drainage improvements, and the realignment of the section line road intersection to replace the skewed intersection with a perpendicular intersection, thereby improving sight-distance.

All proposed improvements will feature two 12-ft. wide driving lanes with 8-ft. wide paved shoulders.

All six bridges will be replaced with either roadway-size or bridge-size RCBs meeting the clear zone requirements.

SH-19 will remain open to traffic during construction.

<input checked="" type="checkbox"/>	Property Owner Notification		Road Closure Letter	<input checked="" type="checkbox"/>	Public/Stakeholder Meeting
<input checked="" type="checkbox"/>	Legal Notice/Website Posting		Small City Letter		None

All documentation, analyses, and agency coordination regarding this Categorical Exclusion are attached to this document and maintained in the project file at the Oklahoma Department of Transportation, Environmental Programs Division.

<u>Criteria Identified in Section III.b.3. of the 2011 FHWA/ODOT Programmatic Agreement for Processing Categorical Exclusions that would require Individual Review and Approval by FHWA:</u>		
Check Yes or No below. If the answer to any of the questions below is Yes, an Individual CE will be required.		
Description/Question	Yes	No
Item(a)		
1. Does the project involve residential or commercial relocation?	X	
2. Does the project involve acquisition of right-of-way not adjacent to the existing facility?	X	
3. Does the project involve property in which another Federal Agency or Federally Recognized Tribe has ownership, oversight or any other encumbrance?	X	
Item(b)		
Does the project involve a determination of adverse effect by Oklahoma State Preservation Office (SHPO) or a designated Tribal Historic Preservation (THPO) in accordance with Section 106? An exception to this would apply if adverse effects are addressed programmatically as part of a previously executed general Section 106 Programmatic Agreement with SHPO, FHWA and others, and a project-specific MOA will not be required.		X
Item (c)		
Does the project involve a Programmatic Section 4(f) or <i>de minimis</i> finding which has not been previously approved by FHWA?		X
Item (d)		
Does the project involve a Section 6(f) property?		X
Item (e)		
Does the project involve any impact on Noise Abatement Criteria (NAC) Category A, B, C or D receptors?	X	

Item (f)		
1. Does the project involve a finding of “may effect, likely to adversely affect” to a federally listed endangered or threatened species or its critical habitat determined during the Section 7 Informal Consultation Process? The exception to this is the American Burying Beetle or any other species which has been addressed under a separate formal programmatic agreement.		X
2. Does the project involve a Section 7 Formal Consultation Process?		X
Item (g)		
Does the project require an Individual Section 404 Permit (This is for major River Crossings, waters or wetlands impact greater than 0.5 AC, Projects with Formal Consultation, or others as determined by USACE)?		X
Item (h)		
Does the project require a Coast Guard Permit?		X
Item (i)		
Does the project involve construction across or adjacent to a river designated as a component in the National System of Wild and Scenic Rivers?		X
Item (j)		
Does the project involve an adverse impact on prime farmland where Natural Resources Conservation Agency (NRCS) has required consideration of alternatives and measures to avoid and minimize impacts?		X
Item (k)		
Does the project involve increase to the base 100 Year floodplain in a regulatory floodway (Zone A-E in a FEMA Map) that will require a flood map revision as determined by the appropriate state or local authority?		X
Item (l)		
Does the project involve any known Superfund site?		X
Item (m)		
Does the project involve any permanent changes to the operation of an Interstate highway, associated interchanges or ramps?		X
Item (n)		
Does the project have potential for disproportionately high and adverse impact on minority or low-income populations, based on known demographics in the project vicinity, extent of R/W, relocations, and other identified impacts?		X
Item (o)		
Does the project have any substantial or public controversy on environmental grounds?		X
Item (p)		
If the project involves road closure or ramp closure, do any of the following conditions apply? (Check the boxes ONLY if the project involves road closure)		
i. No Access will be provided to local traffic or posted		
ii. Through traffic dependent businesses will be affected		
iii. The detour closure will interfere with special events or activities		
iv. The detour or closure will substantially alter the environmental consequences of the action, such as by creating unsafe conditions on the detour route or requiring additional work or expansion to detour routes to carry the additional traffic.		
v. There is a public controversy associated with the detour or closure		

Explanation for Individual CE (If any of the answers above are YES):	
Item for which the answer is YES	Item (a)1
Explanation that CE Classification is appropriate	
<p>A Relocation Plan was completed on June 20, 2019 which determined that seven residential relocations may be necessary due to the impact of proposed right-of-way as depicted in the Proposed Right-of-Way Plans dated March 2019. A Community Impacts Assessment Form was completed to identify Social and Economic (SE) Impacts and an Analysis Specialist Study was completed to identify potential impacts associated with the potential displacements identified in the Relocation Plan. There were no commercial displacements identified in the Relocation Plan which would affect community cohesion or economic growth.</p> <p>For the seven (7) single family residences to be relocated, decent, safe and sanitary housing is available in the project's surrounding area and the potential displacements are located within Census Blocks which do not contain a high-percentage of minority populations, nor are they located within block groups containing a low-income population. The benefits associated with the proposed improvements would include improved traffic operations and enhanced safety for local traffic. No disproportionately high and adverse impacts on minority or low-income populations are anticipated as a result of the project. In accordance with the provisions of E.O. 12898 and FHWA order 6640.23A, no further Environmental Justice analysis is required.</p>	
Item for which the answer is YES	Item (e)
Explanation that CE Classification is appropriate	
<p>A February 2018 Noise Study Report was conducted for this project. Analysis utilized the FHWA Traffic Noise Model version 2.5 in accordance with FHWA 23 CFR 772 and complies with the ODOT Noise Policy dated July 13, 2011. Twenty-eight (28) model receptor locations were analyzed consisting of twenty-four (24) single family residential homes, one (1) day care, one (1) place of worship, and two (2) commercial facilities. Based upon the build alternative for the future condition (design year 2040), one (1) residential receptor (R-3; JP 30425(07)) will approach the 67 dB(A) LEQ (h) for NAC Activity Category B. No receptors will experience a substantial increase (15 dB) in sound levels over the current condition. Noise mitigation in the form of a free-standing noise wall was considered for the impacted receptor which has direct driveway access onto SH-19. Without access control, the gap needed in the noise wall for the driveway connection would make noise abatement measures ineffective and prove not feasible. Therefore, noise mitigation is not recommended for this project.</p>	

Commitments (Check Applicable ones)	
<input checked="" type="checkbox"/>	Plan notes requiring avoidance of cultural resources in off-project areas will be added to the final project plans under "Environmental Mitigation Notes" per policy Directive C-201-2D(2).
<input type="checkbox"/>	Properties eligible for the National Register of Historic Places (NRHP) have been identified within the project area. Plans need to be submitted to Environmental Programs Division by the Designer for further coordination with the State Historic Preservation Office (SHPO) prior to the bid solicitation process or construction.
<input type="checkbox"/>	Properties eligible for the National Register of Historic Places (NRHP) have been identified within the project area. The State Historic Preservation Office (SHPO)'s approval is based on the project as currently proposed. The following Plan notes will be added to the final project plans under "Environmental Mitigation Notes" per policy Directive C-201-2D(2).

	(Only for Special Projects) Properties eligible for the National Register of Historic Places (NRHP) have been identified within the project area. Further coordination with the State Historic Preservation Office (SHPO) is required by the ODOT Project Management's Special Projects Branch prior to the bid solicitation process or construction. The SHPO letter which cites the information needed to proceed is included in the Appendix. The file number from the SHPO letter should be referenced in all correspondence with SHPO. Copies of such coordination should be provided to the Environmental Programs Division for the project record.
	(Only for Special Projects) Properties eligible for the National Register of Historic Places (NRHP) have been identified within the project area. The State Historic Preservation Office (SHPO)'s approval is based on the project as currently proposed. The following Plan notes will be added to the final project plans under "Environmental Mitigation Notes" per policy Directive C-201-2D(2).
	The project occurs in an area where the American burying beetle (ABB) occurs. Special Provision 656-4 for ABB will be added to the final project plans/contract per policy Directive C-201-2D(2).
X	<p>Survey for the following species need to be completed prior to constructions and plan notes will be provided after the completion of the survey (<i>List species survey requirements below</i>)</p> <p>Bald Eagle Note: Suitable nesting, roosting or foraging habitat for the Bald Eagle occurs within the project's action area. The Bald Eagle nesting season in Oklahoma extends from September 16, through May 31. The Resident Engineer shall contact the ODOT Biologist at 405-210-3671 to schedule a nest survey. Nest search surveys can only be conducted when leaves are not on the trees typically between December 1st and February 28th. No work may occur within suitable Bald Eagle habitat, located the full extent of the study area, during the nesting season (September 16, through May 31) until the completion of the survey by the ODOT Biologist. If nests are observed, a no-work buffer up to a distance of 1000 feet shall be placed around the nest. The exact distance of the buffer zone shall be established by the ODOT Biologist in consultation with US Fish and Wildlife Services. If the buffer cannot be maintained, all clearing, external construction and landscaping activities, within the buffer, shall be conducted between June 1 and September 15 (outside the nesting season).</p>
	Plan notes requiring construction season restrictions for the following species will be added to the final project plans under "Environmental Mitigation Notes" per policy Directive C-201-2D(2). (<i>List species or notes below</i>)
	Plan notes requiring avoidance and minimization of impacts for the following species will be added to the final project plans under "Environmental Mitigation Notes" per policy Directive C-201-2D(2). (<i>List species below</i>)

	<p>The following Plan notes requiring construction season restrictions for the migratory birds will be added to the final project plans under “Environmental Mitigation Notes” per policy Directive C-201-2D(2). (<i>List notes below</i>)</p> <p>Migratory Bird Note: Migratory birds are protected by the federal Migratory Bird Treaty Act. Many birds commonly use bridges and culverts for nesting. The nesting season for most migratory bird species extends from March 1 to August 31. Migratory bird nesting use of the following bridges and culverts was observed:</p> <table border="1"> <tbody> <tr> <td>NBI:08712 (RCB bridge)</td><td>RCB at STA.593-37</td></tr> <tr> <td>NBI:09046 (Dry Creek RCB)</td><td>RCB at STA.655+57.7</td></tr> <tr> <td>NBI:09048 (RCB bridge)</td><td>RCB at STA.682+89.6</td></tr> <tr> <td>NBI:11070 (RCB bridge)</td><td>RCB at STA.692+09</td></tr> <tr> <td>NBI:11089 (Soldier Creek slab span)</td><td>RCB at STA.792+77.9</td></tr> <tr> <td>NBI:11119 (concrete slab)</td><td>RCB at STA.876+81.5</td></tr> <tr> <td>RCB at STA.495+25</td><td>RCB at STA.884+18.6</td></tr> <tr> <td>RCB at STA.581+13.9</td><td>RCB at STA.908+97</td></tr> </tbody> </table>	NBI:08712 (RCB bridge)	RCB at STA.593-37	NBI:09046 (Dry Creek RCB)	RCB at STA.655+57.7	NBI:09048 (RCB bridge)	RCB at STA.682+89.6	NBI:11070 (RCB bridge)	RCB at STA.692+09	NBI:11089 (Soldier Creek slab span)	RCB at STA.792+77.9	NBI:11119 (concrete slab)	RCB at STA.876+81.5	RCB at STA.495+25	RCB at STA.884+18.6	RCB at STA.581+13.9	RCB at STA.908+97
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RCB at STA.581+13.9	RCB at STA.908+97																
X	<p>Painting, repair, retrofit, rehabilitation or demolition of the existing bridges and culverts shall be conducted between September 1, and February 28, when migratory bird nests are not occupied. If painting, repair, retrofit, rehabilitation or demolition cannot be completed between September 1 and February 28, the bridges and culverts shall be protected from new nest establishment prior to March 1, by means that do not result in bird death or injury. Options include the exclusion of adult birds from suitable nest sites on or within a structure by the placement of weather-resistant polypropylene netting with 0.25-inch or smaller openings, prior to March 1. Methods other than netting must be pre-approved by the ODOT Biologist.</p> <p>Although no nests were observed on all other structures, the birds may occupy the structures in the future. The Resident Engineer shall contact the ODOT Biologist at 405-210-3671 if any bird use of these structures is observed. If birds are observed then painting, repair, retrofit, rehabilitation or demolition of the existing bridges and culverts shall be conducted between September 1, and February 28 (when migratory bird nests are not occupied).</p>																
X	<p>The action may involve work in potentially jurisdictional waters and potentially jurisdictional wetlands. For State Projects, the 404 permit application form needs to be submitted by the Designer through Project Management Division to Environmental Programs Division at the time of Right-of-Way submittal for evaluation and determination of the appropriate Clean Water Act Section 404 permit application for the project. For Local Government Projects or Special Projects, a copy of the 404 permit obtained by the County/City should be submitted by Local Government Division or Special Projects to Environmental Programs Division for the Project File.</p>																
	<p>The action involves work in Critical Resource Waters and requires Pre Construction Notification (PCN) to USACE regardless of the area of impact. For Local Government Projects or Special Projects, a copy of the PCN by the County should be submitted by Local Government Division or Special Projects Branch to Environmental Programs Division for the Project File.</p>																
	<p>The action will require a FEMA Map revision.</p>																
	<p>Plan notes requiring avoidance of potential hazardous materials remains areas will be added to the final project plans under “Environmental Mitigation Notes” per policy Directive C-201-2D(2).</p>																
	<p>The Department’s Hazardous Coordinator has determined that a Preliminary Site Investigation (PSI) is required for this project. Construction Plans need to be submitted by the Designer to Environmental Programs Division at the time of Right-of-Way submittal for the PSI.</p>																
	<p>The following plan note regarding Road Closure will be added to the plans (<i>Add plan notes restricting road closure</i>).</p>																
	<p>(Only for Local Government Projects) The roadway will be closed to traffic during construction. The County or City will be responsible for notifying all local residential and commercial property owners, schools, and emergency services providers prior to construction. The County or City will be responsible for posting the detour routes. The Contractor will provide access to local property owners at all times during construction.</p>																

	<i>(Only for Local Government Projects)</i> The Local Government Project Manager shall coordinate any required species surveys with Environmental Programs Division prior to letting the project. Note the seasonal restrictions for surveys in the biological studies summary.
	The following Airport/Airfield located within 4 miles of this project. This action may require notifying the Federal Aviation Administration (FAA) of proposed construction via FAA Form 7460-1 prior to construction. <i>(List the name of the Airport below)</i>
	Other <i>(List Commitment below)</i>
	Other <i>(List Commitment below)</i>

The mitigation measures above should be discussed at all Pre-work conferences per Policy Directive C-201-2E(1). The Designer shall provide a **copy of the final plans with the mitigation notes** to Environmental Programs Division for the project Records.

Development of the project including coordination and assessment of potential social, economic and environmental impacts has been considered in accordance with DOT ORDER 5610.1C, and CEQ REGULATIONS 40 CFR 1500 - 1508 as amended, 23 CFR 771.117 and the 2011 FHWA/ODOT Programmatic Agreement for processing of categorical exclusions. Implementation of this action as a “Categorical Exclusion” will satisfy the requirements of the National Environmental Policy Act.

Preparer/Reviewer Signatures

<i>Melissa Booth</i>	5/21/2020
Environmental Consultant Project Manager (If Applicable)	Date
Triad Design Group	
Environmental Consultant Firm Name (If Applicable)	Date
County Commissioner or City Manager (For Local Government Projects)	Date
Greg Worrell	Digitally signed by Greg Worrell Date: 2020.05.22 12:06:47 -05'00'
ODOT Environmental Project Manager	Date
Assistant Environmental Programs Division Engineer	Date
Sivanuja Sundaram	Digitally signed by Sivanuja Sundaram Date: 2020.05.22 12:48:04 -05'00'
Environmental Programs Division Engineer	Date
CONCLUSION:	
ODOT has reviewed the conditions identified in Section IIIb.3 of Federal Highway Administration (FHWA)/ODOT Programmatic Agreement for Processing Categorical Exclusions (CE) and determined that an Individual CE must be submitted to FHWA for approval.	
<input checked="" type="checkbox"/>	YES
	NO

For Individual CEs requiring FHWA Approval:

Concurrence that this project qualifies for a Categorical Exclusion:


<i>Ralph Nguyen</i>	6/3/2020
Environmental Programs Manager, FHWA	Date

Attachments: Location Map
 Memos with Plan Notes
 NEPA On Hold Memo if applicable
 Plans and Footprint
 Studies
 NEPA Status Report

Distribution List (Check Applicable Ones)

<input checked="" type="checkbox"/>	Project Management Division (All State Projects)
<input checked="" type="checkbox"/>	Roadway Design Division (All State projects with the exception of projects from Traffic Division and Special Projects)
<input checked="" type="checkbox"/>	Bridge Division (All State Bridge Projects)
	Traffic Division (For projects from Traffic Division)
	Local Government Division (County or City Projects)
	Special Projects (Special Projects Only)
	Safe Routes to School Coordinator (SRTS Projects Only)
<input checked="" type="checkbox"/>	Field Division Engineer (All Projects)
<input checked="" type="checkbox"/>	Right-of-Way Division (All Projects)
<input checked="" type="checkbox"/>	Office Engineer Division (All Projects)
<input checked="" type="checkbox"/>	FHWA (All Projects. Place Copy of Complete Document on FHWA's Directory)

Copy to: Reading File

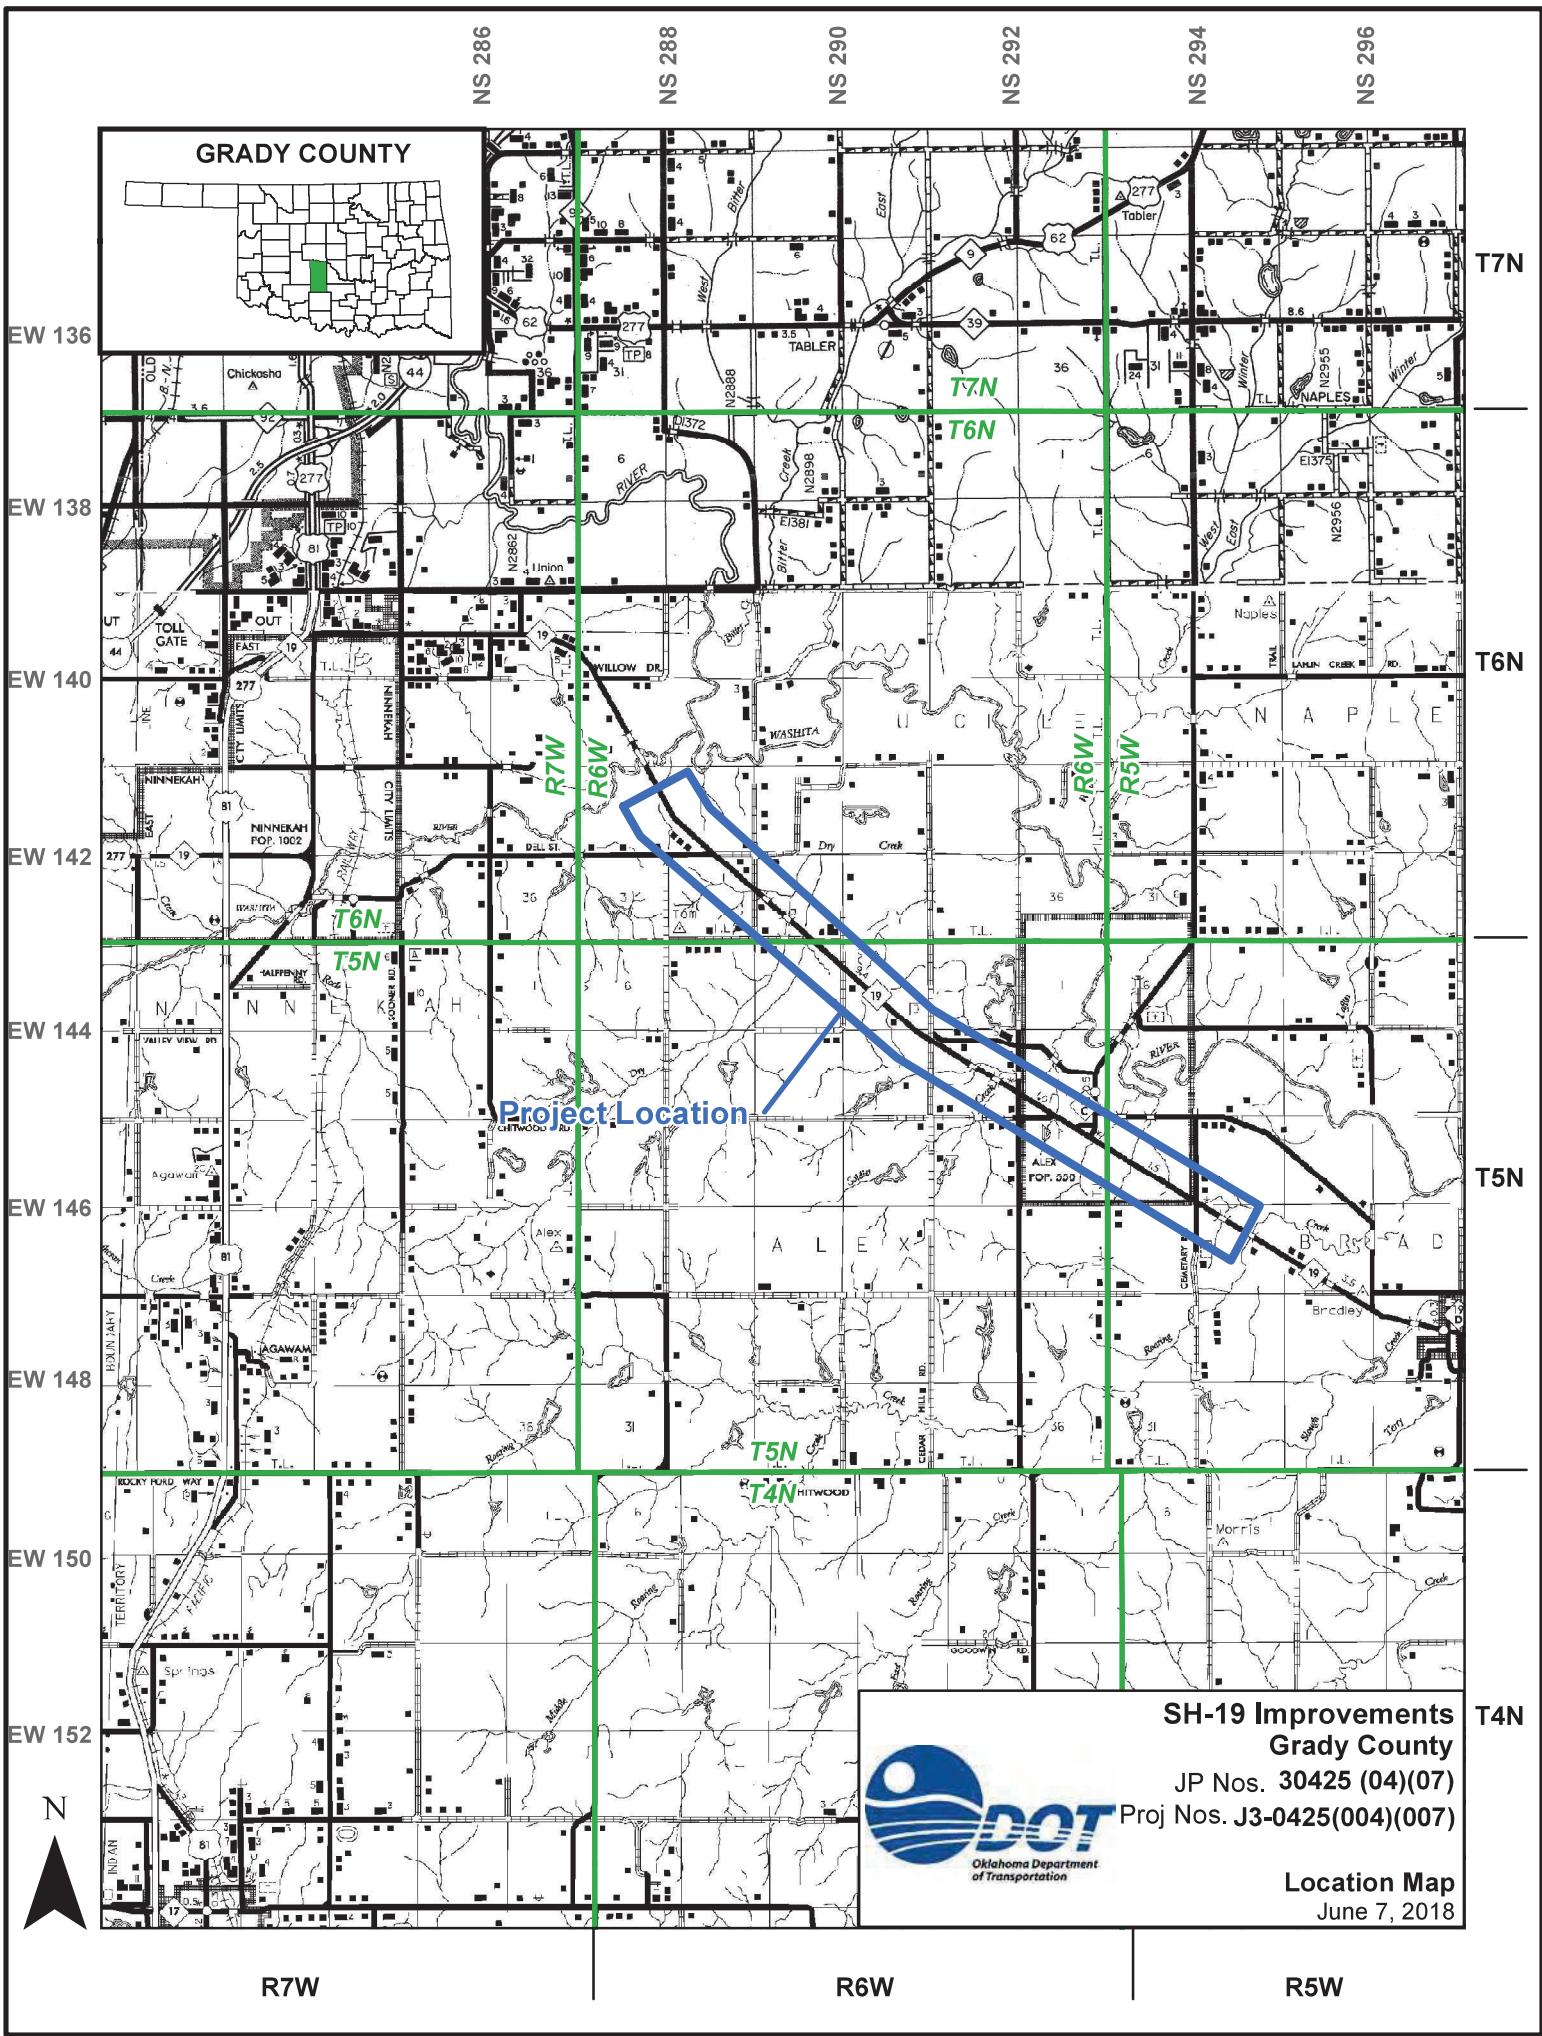



Oklahoma Department of Transportation
Environmental Programs Division, Office 405.521.3050 / Fax 405.522.5193

DATE: December 5, 2019

TO: Project Management Division

FROM: Environmental Programs Division 


SUBJECT: Grady County: JP 30425(04)(07); Proposed Improvements to SH-19 in Grady County, Oklahoma.

The NRHP-eligible Craddock Dugout and NRHP-eligible archaeological site 34GD299 is located immediately north of the proposed right-of-way of the referenced project. Impact to the building, archaeological site, and immediate surrounding area must be avoided. In order to avoid effects to these resources, the following notes should be added to the plans to ensure that construction or construction-related activities do not impact the Craddock Dugout/Site 34GD299. Please have the following note added to a section of the project plans entitled “Environmental Mitigation Notes” per Policy Directive C-201-2D(2):

Temporary fencing will be used to demarcate the project R/W from Stations: 503+50 LT through 508+50 LT. No equipment staging, borrow, haul roads, spoil dumps, vehicle parking, or any other project related off-site facilities or use should occur beyond the fencing in this area during construction activities.

ODOT-Cultural Resources Program should be invited to all pre-work conferences to discuss these measures, per Policy Directive C-201-2E(1). If you have any questions, please contact the Cultural Resources Program at 405-325-7201.

SAS

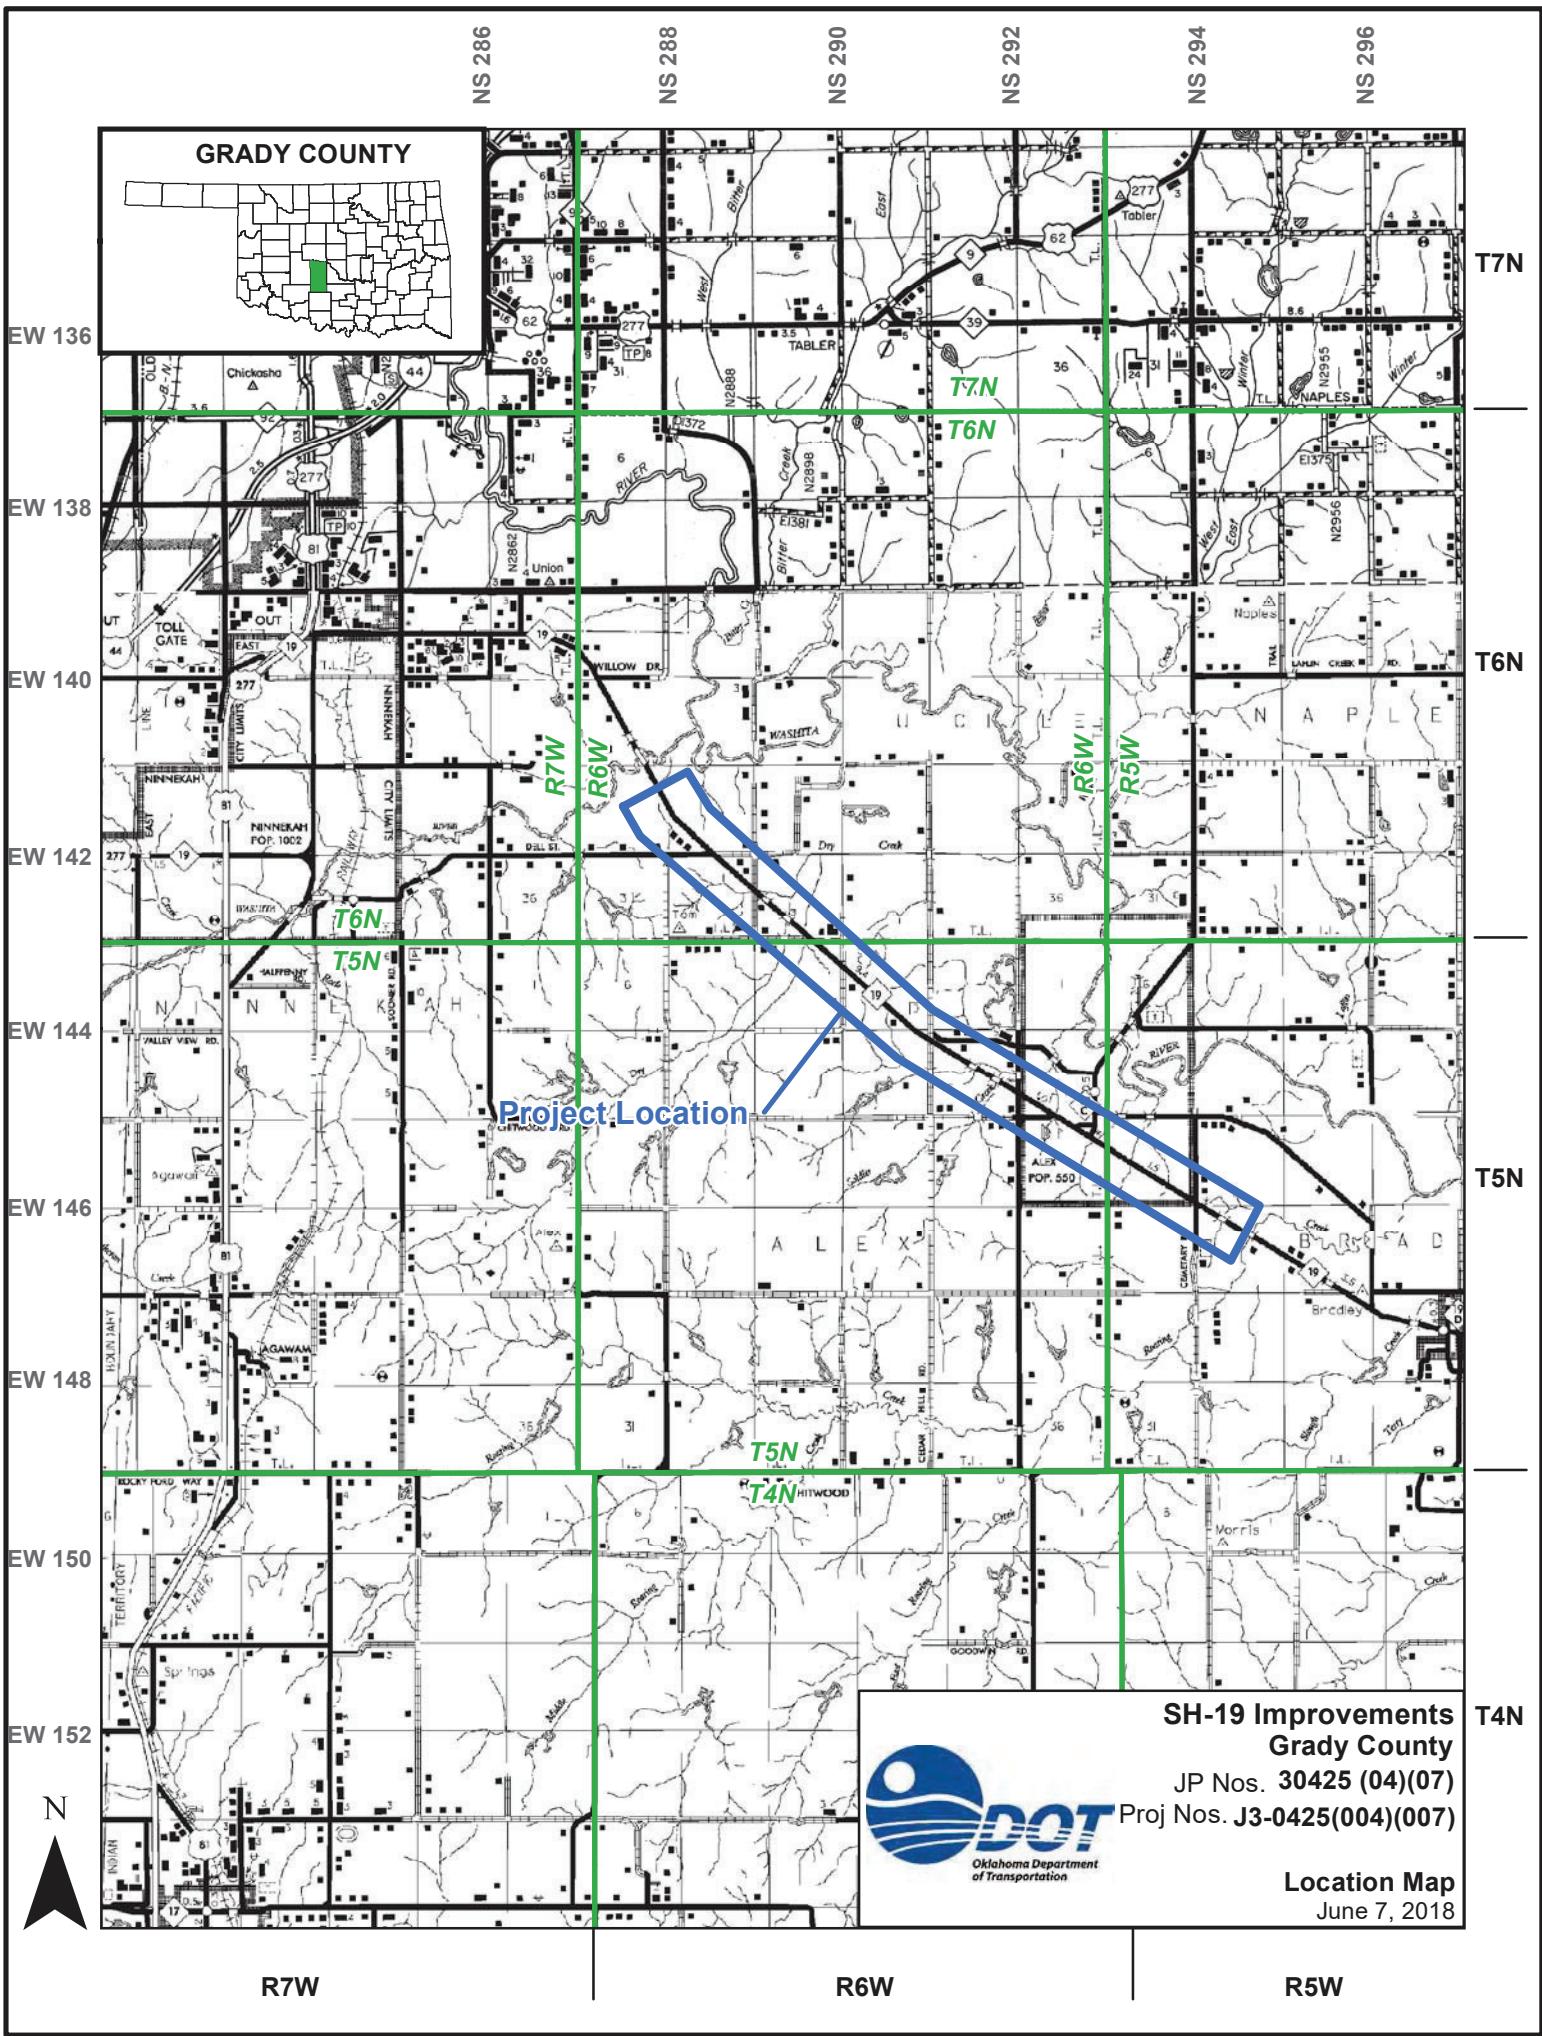



Oklahoma Department of Transportation
Environmental Programs Division, Office 405.521.3050 / Fax 405.522.5193

DATE: December 5, 2019

TO: Project Management Division

FROM: Environmental Programs Division

A handwritten signature consisting of the initials "S. S. S." enclosed in a stylized oval.

SUBJECT: Grady County: JP 30425(04)(07); Proposed Improvements to SH-19 in Grady County, Oklahoma.

The NRHP-eligible Craddock Dugout and NRHP-eligible archaeological site 34GD299 is located immediately north of the proposed right-of-way of the referenced project. Impact to the building, archaeological site, and immediate surrounding area must be avoided. In order to avoid effects to these resources, the following notes should be added to the plans to ensure that construction or construction-related activities do not impact the Craddock Dugout/Site 34GD299. Please have the following note added to a section of the project plans entitled "Environmental Mitigation Notes" per Policy Directive C-201-2D(2):

Temporary fencing will be used to demarcate the project R/W from Stations: 503+50 LT through 508+50 LT. No equipment staging, borrow, haul roads, spoil dumps, vehicle parking, or any other project related off-site facilities or use should occur beyond the fencing in this area during construction activities.

ODOT-Cultural Resources Program should be invited to all pre-work conferences to discuss these measures, per Policy Directive C-201-2E(1). If you have any questions, please contact the Cultural Resources Program at 405-325-7201.

SAS

PLANS OR FOOTPRINTS

STATE OF OKLAHOMA
DEPARTMENT OF TRANSPORTATION

FOR SURVEY CONTROL DATA
SEE SURVEY DATA SHEETS


STATE HIGHWAY
FEDERAL AID PROJECT NO. J3-0425(007)
GRADE, DRAIN, BRIDGE & SURFACE
SH 19
GRADY COUNTY

CONTROL SECTION NO. 19-26-18

STATE JOB NO. 30425(07)

BRIDGE "A" LOCATION NO. 2618-0705X NBIS NO. 09046; NEW NB 1 NO. 32291
BRIDGE "B" LOCATION NO. 2618-0721X NBIS NO. 08714; (TO BE REMOVED)
BRIDGE "C" LOCATION NO. 2618-0729X NBIS NO. 09048; NEW NB 1 NO. 32290
BRIDGE "D" LOCATION NO. 2618-0993X NBIS NO. 11070; NEW NB 1 NO. 32289
BRIDGE "E" LOCATION NO. 2618-1010X NBIS NO. 11089; NEW NB 1 NO. 32288

CONTROL SUB-SECTION NO. 4.98

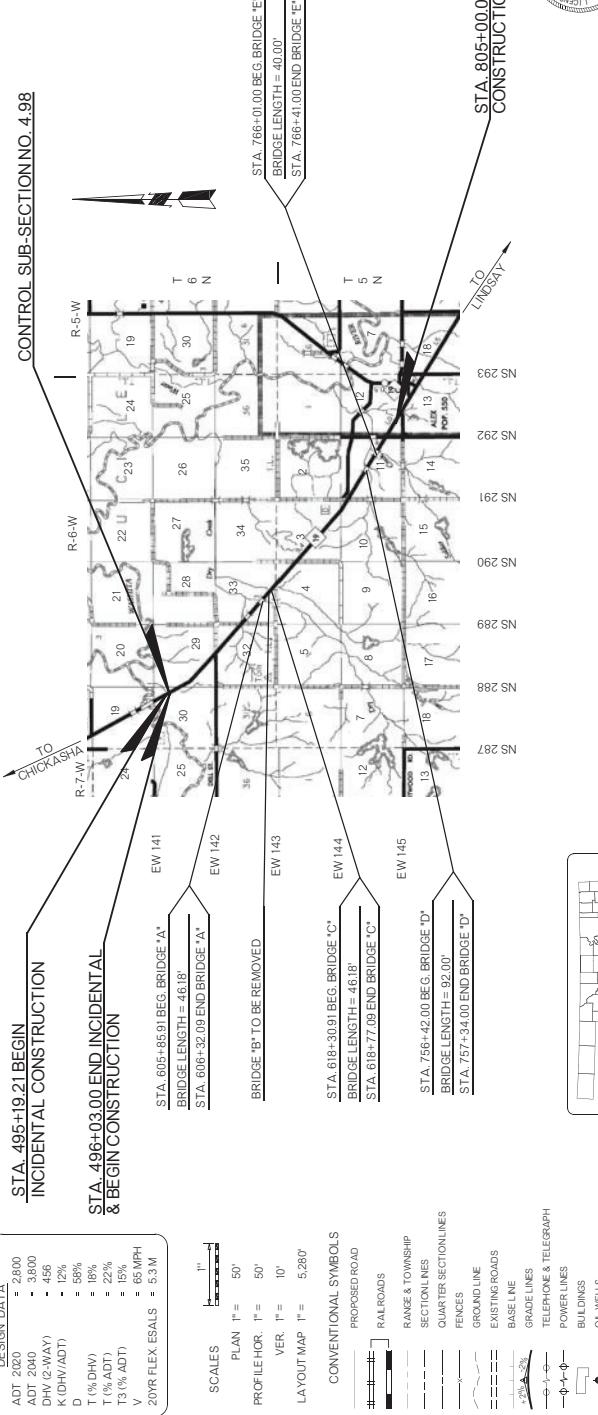

INDEX OF SHEETS
0001 TITLE SHEET
003-0003 TYPICAL SECTIONS
B01-B08 BRIDGE & SHEETS
R01-R027 PLAN AND PROFILE SHEETS
S001-S021 SURVEY DATA SHEET TS SWO 20801
S001-S026 SURVEY DATA SHEET TS SWO 520710
X001-X03 CROSS SECTIONS

CASSANDRA PINTA
LICENCED PROFESSIONAL ENGINEER NO. 27216

OKLAHOMA
DEPARTMENT OF TRANSPORTATION
DATE APPROVED _____
BY _____


DEPARTMENT OF TRANSPORTATION
FEDERAL HIGHWAY ADMINISTRATION
DATE APPROVED _____
BY _____

DEPARTMENT OF TRANSPORTATION
DIVISION ADMINISTRATOR
DATE APPROVED _____
BY _____

OKLAHOMA
COUNTY
GRADY COUNTY
HIGHWAY
SH 19
SHEET NO. 0001

2009 OKLAHOMA STANDARD SPECIFICATIONS FOR HIGHWAY CONSTRUCTION GOVERN APPROVED BY
THE U.S. DEPARTMENT OF TRANSPORTATION FEDERAL HIGHWAY ADMINISTRATION JANUARY 4, 2010

REVISED
PROPOSED R/W
AUGUST 14, 2019

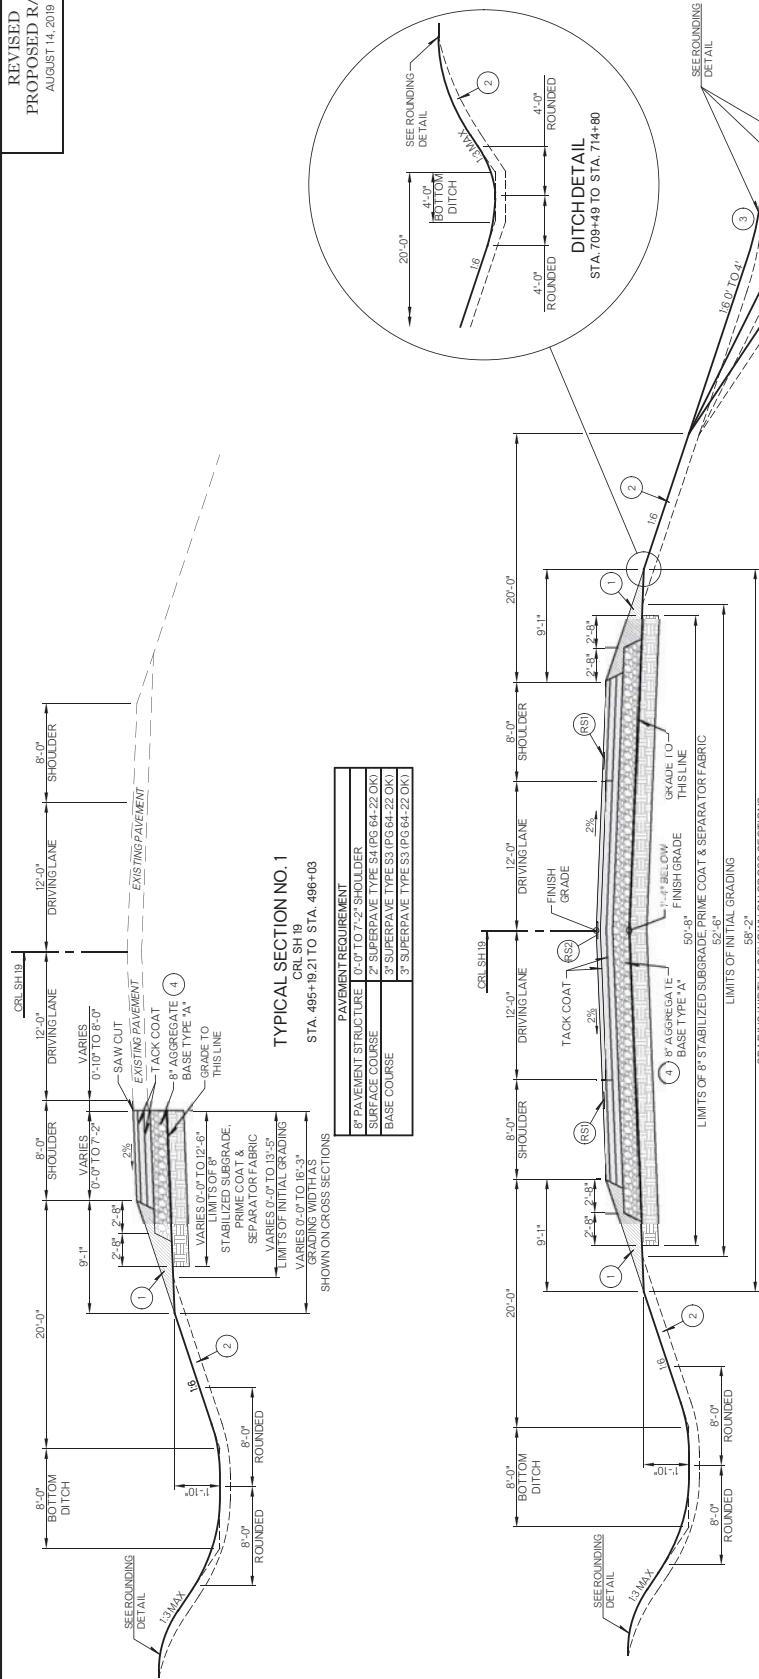

TYPICAL SECTION NO. 1


STA. 495+9.21 TO STA. 496-03
PAVEMENT REQUIREMENT

TYPICAL SECTION NO. 2

DOI 10.1111/j.1467-954X.2009.00741.x

- ROUNDING DETAILS**

INTERSECTION OF CUT AND/OR FILL SLOPES WITH GROUND LINE TO BE ROUNDED AS PART OF FINISHING OPERATIONS. ROUNDING SHALL BE 5' MINIMUM FOR SMALL ER CUTS AND FILLS TO 15' MAXIMUM FOR LARGER CUTS AND FILLS OR AS DESIGNATED BY THE ENGINEER. COST OF ROUNDING TO BE INCLUDED IN THE PRICE FOR OTHER ITEMS OF WORK.

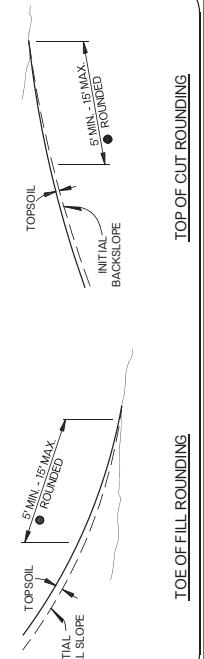

TOP OF CIVIT BOI INDING

- (1) BACKFILL NOTE:
TO BE BACKFILLED AS PART OF THE FINISHING OPERATIONS. QUANTITY IS MEASURE IN
T.B.C. TYPE E.


(1A) BACKFILL NOTE:
TO BE BACKFILLED AS PART OF THE FINISHING OPERATIONS COST TO BE INCLUDED IN
OTHER ITEMS OF WORK.

TOPSOIL NOTE.
THE CONTRACTOR SHALL STRIP ALL OF THE AVAILABLE TOPSOIL, STOCKPILE IT, AND
PLACE IT BACK ON THE SECTION IN ACCORDANCE WITH SECTION 205 OF THE
STANDARD SPECIFICATIONS. RESERVED TOPSOIL SHALL BE SPREAD FIRST ON THE
COMPLETED SLOPES OF THE CUT SECTIONS AND THE REMAINDER ON COMPLETED FILL
SLOPES OR OTHER PRIORITY AREAS LOCATED BY THE ENGINEER. ADDITIONAL
COSTS ASSOCIATED WITH LOCATIONS SHALL BE INCLUDED IN THE PAY ITEM FOR
SALVAGED TOPSOIL, LUMP SUM.

TYPICAL SECTIONS

State

PROPOSED
R/W
JUNE 2019

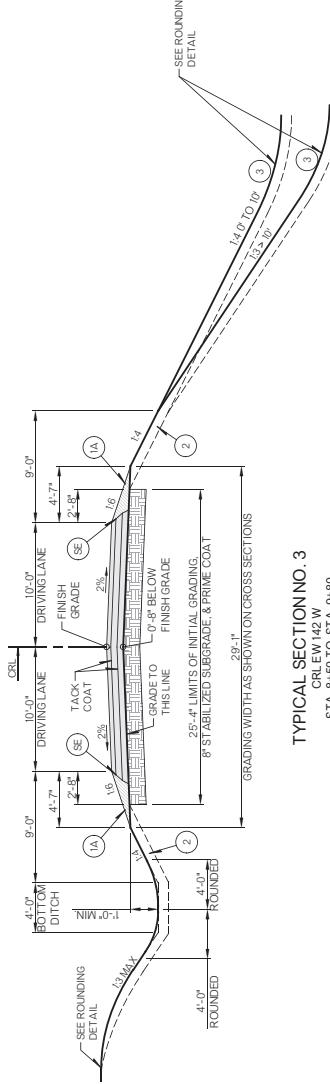


TYPICAL SECTION NO. 3

CRL EW 142 W

STA. 10+20 TO STA. 13+50 CRL NS 290 STA. 34+50 TO STA. 39+80 STA. 40+20 TO STA. 46+00 CRL NS 291 STA. 14+00 TO STA. 19+80 STA. 45+50 TO STA. 49+88 STA. 20+20 TO STA. 23+50 STA. 60+20 TO STA. 64+00 STA. 27+00 TO STA. 29+80

PAVEMENT REQUIREMENT

8' PAVEMENT STRUCTURE: 10'-0" DRIVING LANES		
SURFACE COURSE	2' SUPERPAVE TYPE S4 (PG 64-22 OK)	3' SUPERPAVE TYPE S5 (PG 64-22 OK)
BASE COURSE	3' STABILIZED SUBGRADE & PRIME COAT	

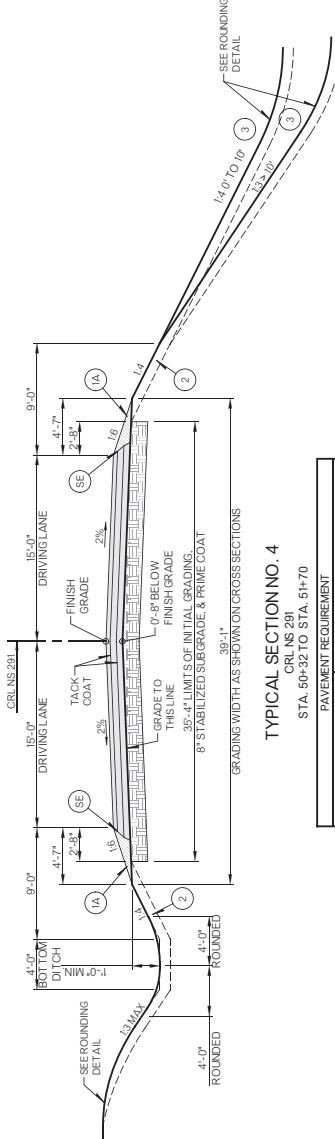


TYPICAL SECTION NO. 4

CRL NS 291

STA. 50+32 TO STA. 51+70

8' PAVEMENT STRUCTURE: 10'-0" DRIVING LANES		
SURFACE COURSE	2' SUPERPAVE TYPE S4 (PG 64-22 OK)	3' SUPERPAVE TYPE S5 (PG 64-22 OK)
BASE COURSE	3' STABILIZED SUBGRADE & PRIME COAT	

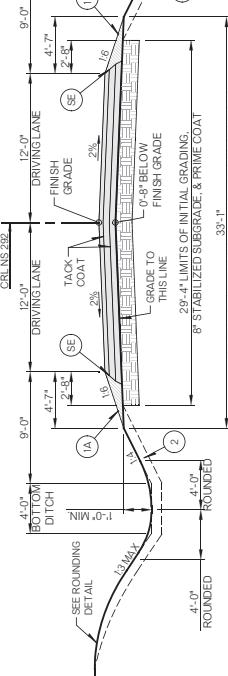

TYPICAL SECTION NO. 5

CRL NS 292

STA. 57+50 TO STA. 59+80

8' PAVEMENT STRUCTURE: 12'-0" DRIVING LANES		
SURFACE COURSE	2' SUPERPAVE TYPE S3 (PG 64-22 OK)	3' SUPERPAVE TYPE S3 (PG 64-22 OK)
BASE COURSE	3' STABILIZED SUBGRADE & PRIME COAT	


- (1) SEE BACKFILL NOTE SHEET NO. 0002.
- (2) SEE TOPSOIL NOTE SHEET NO. 0002.
- (3) SEE DISTANCE MEASURED NOTE SHEET NO. 0002.
- (4) SEE PRIME COAT NOTE SHEET NO. 0002.
- (5) SAFETY EDGE.

THIS DOCUMENT IS PRELIMINARY IN NATURE AND IS NOT A FINAL SIGNED AND SEALED DOCUMENT.

Sheet Job No. 30425(07) Sheet No. 0003

GRADY COUNTY SH 19

PROPOSED
R/W
JUNE 2019

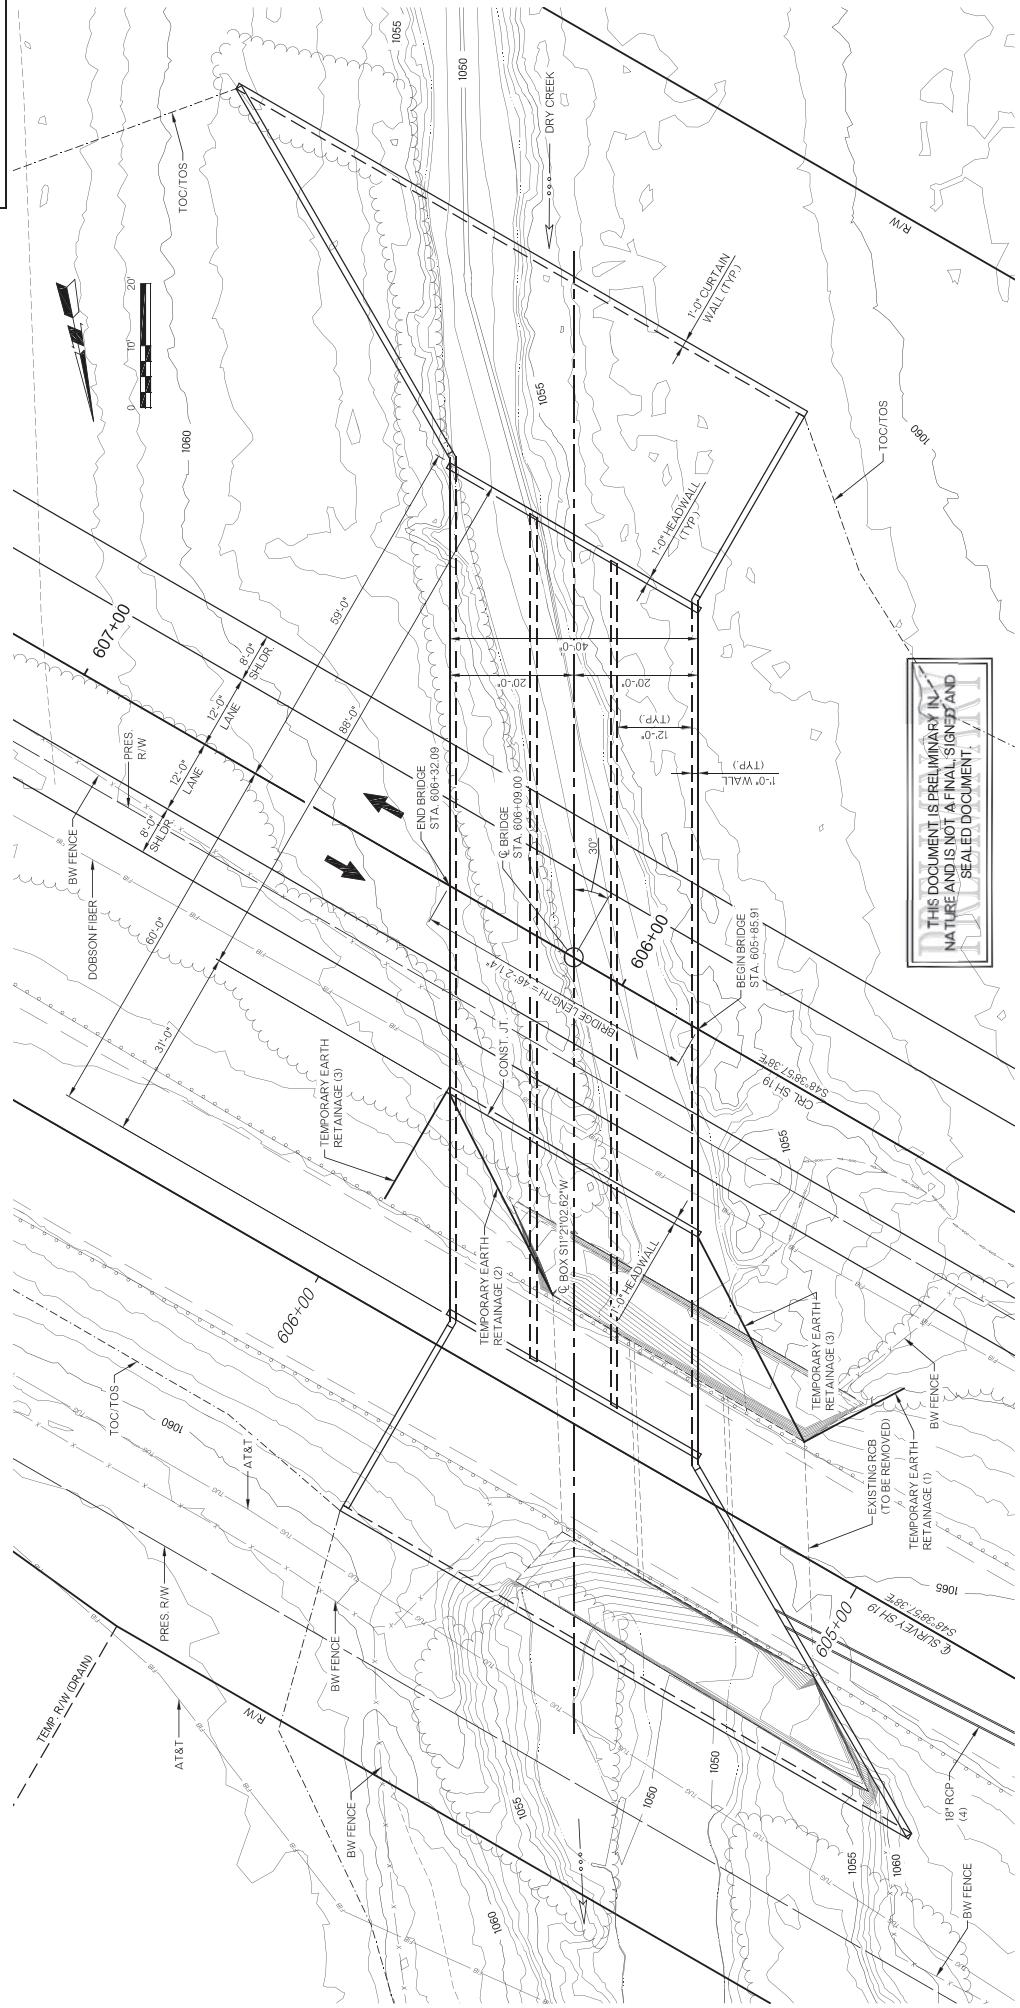

BMH114 - 36x58' REBAR 2 FT. SOUTH OF BWF
48.00' LT.
© SURVEY STA. 599-57,
ELEV = 1089.3886

CONST. 3-12'x10' BRIDGE BOX WITH STD.
HEADWALLS, WINGS, APRONS AND 4'
CURTAINWALLS, SKEWED 30° R.F.

NOTES
ALL STATIONING FOLLOWS CRL SH 19, UNLESS NOTED OTHERWISE.
FOR ELEVATION VIEW SEE SHEET NO B902.
SEE SHEET NO B02 FOR DESIGN DATA, FINISH GRADE DATA, HYDRAULIC DATA, SUMMARY,
INDEX OF SHEETS, AND EXISTING BRIDGE NOTE.
FOR CHANNEL WORK DETAILS, SEE THE CHANNEL PLAN AND PROFILE SHEETS AND
CROSS-SECTIONS (ROADWAY ITEMS).


PLAN
SCALE 1=10'

- NOTES
(1) TEMPORARY EARTH RETAINAGE FOR EXISTING RCB END SECTION REMOVAL.
(2) TEMPORARY EARTH RETAINAGE FOR EXISTING RCB END SECTION REMOVAL AND
NEW RCB CONSTRUCTION.
(3) TEMPORARY EARTH RETAINAGE FOR NEW RCB CONSTRUCTION.
(4) SEE ROADWAY PLAN AND PROFILE SHEETS AND CROSS SECTION SHEETS FOR
ADDITIONAL INFORMATION.

BMH115 - 36x58' REBAR 1 FT. IN OF BRACE POST
37.00' RT.
© SURVEY STA. 607-19,
ELEV. = 1060.4918

GENERAL PLAN AND ELEVATION
(SHEET 1 OF 2)
CONST. TRIPLE 12'x10'x17.4' LG. BOX, SKEWED 30° R.F., AT CRL STA. 606-09
Sheet No 304-25(07)
Bridge AA
SH 19 OVER DRY CREEK
Site Job No. 304-25(07)

PROPOSED
R/W
JUNE 2019

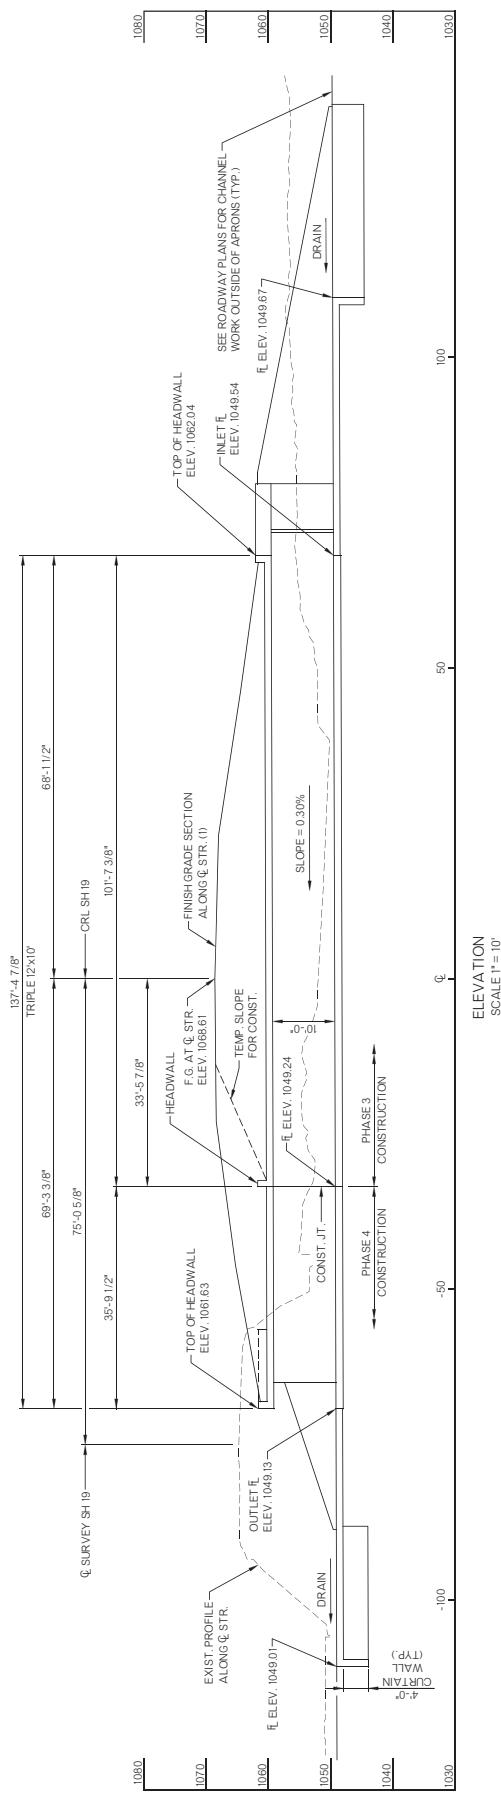

INDEX OF OBJECTS AND CELESTIAL

NO. XX
BB001
DESCRIPTION PAY QUANTITIES AND GENERAL NOTES
GENERAL PLAN AND ELEVATION (SHEET 1 OF 2)

HYDRAULIC DATA - BRIDGE 'A'			
DRY GROUND			
TOTAL D.A.	= 76.6 SQ. MI.		
CONTROLLED D.A.	= 4.53 SQ. MI.		
EFFECTIVE D.A.	= 3.35 SQ. MI.		
FREQ.	Q.C(s)	C/W(t)	V(tips)

FINISH GRADE DATA
CRL SH 19

SUMMARY OF QUANTITIES - BRIDGE "A"

UNCLASSIFIED EXCAVATION	CY	X-XX
STRUCTURAL EXCAVATION UNCLASSIFIED	CY	X-XX
TEMPORARY EARTH RETAINAGE	LSUM	X-XX
GLASSA CONCRETE	CY	X-XX
REINFORCING STEEL	LB	X-XX
REMOVAL OF EXISTING BRIDGE STRUCTURE	LSUM	X-XX

FOR CHANNEL WORK DETAILS, SEE THE CHANNEL PLAN AND PROFILE SHEETS AND CROSS-SECTIONS. (ROADWAY ITEMS).

EXISTING BRIDGE NOTE:
THE EXISTING BRIDGE SHALL BE
REMOVED IN ACCORDANCE WITH
THE NOTES ON SHEET XX.

BRIDGE - A
SH 19 OVER DRY CREEK
GENE


CONST. TRIPLE 12'x10'x137'-4" LG. BOX, SKEWED 30° RF., AT C.R.L. ST.

(S)


10 of 10

AT CRL STA. 606+09

2)

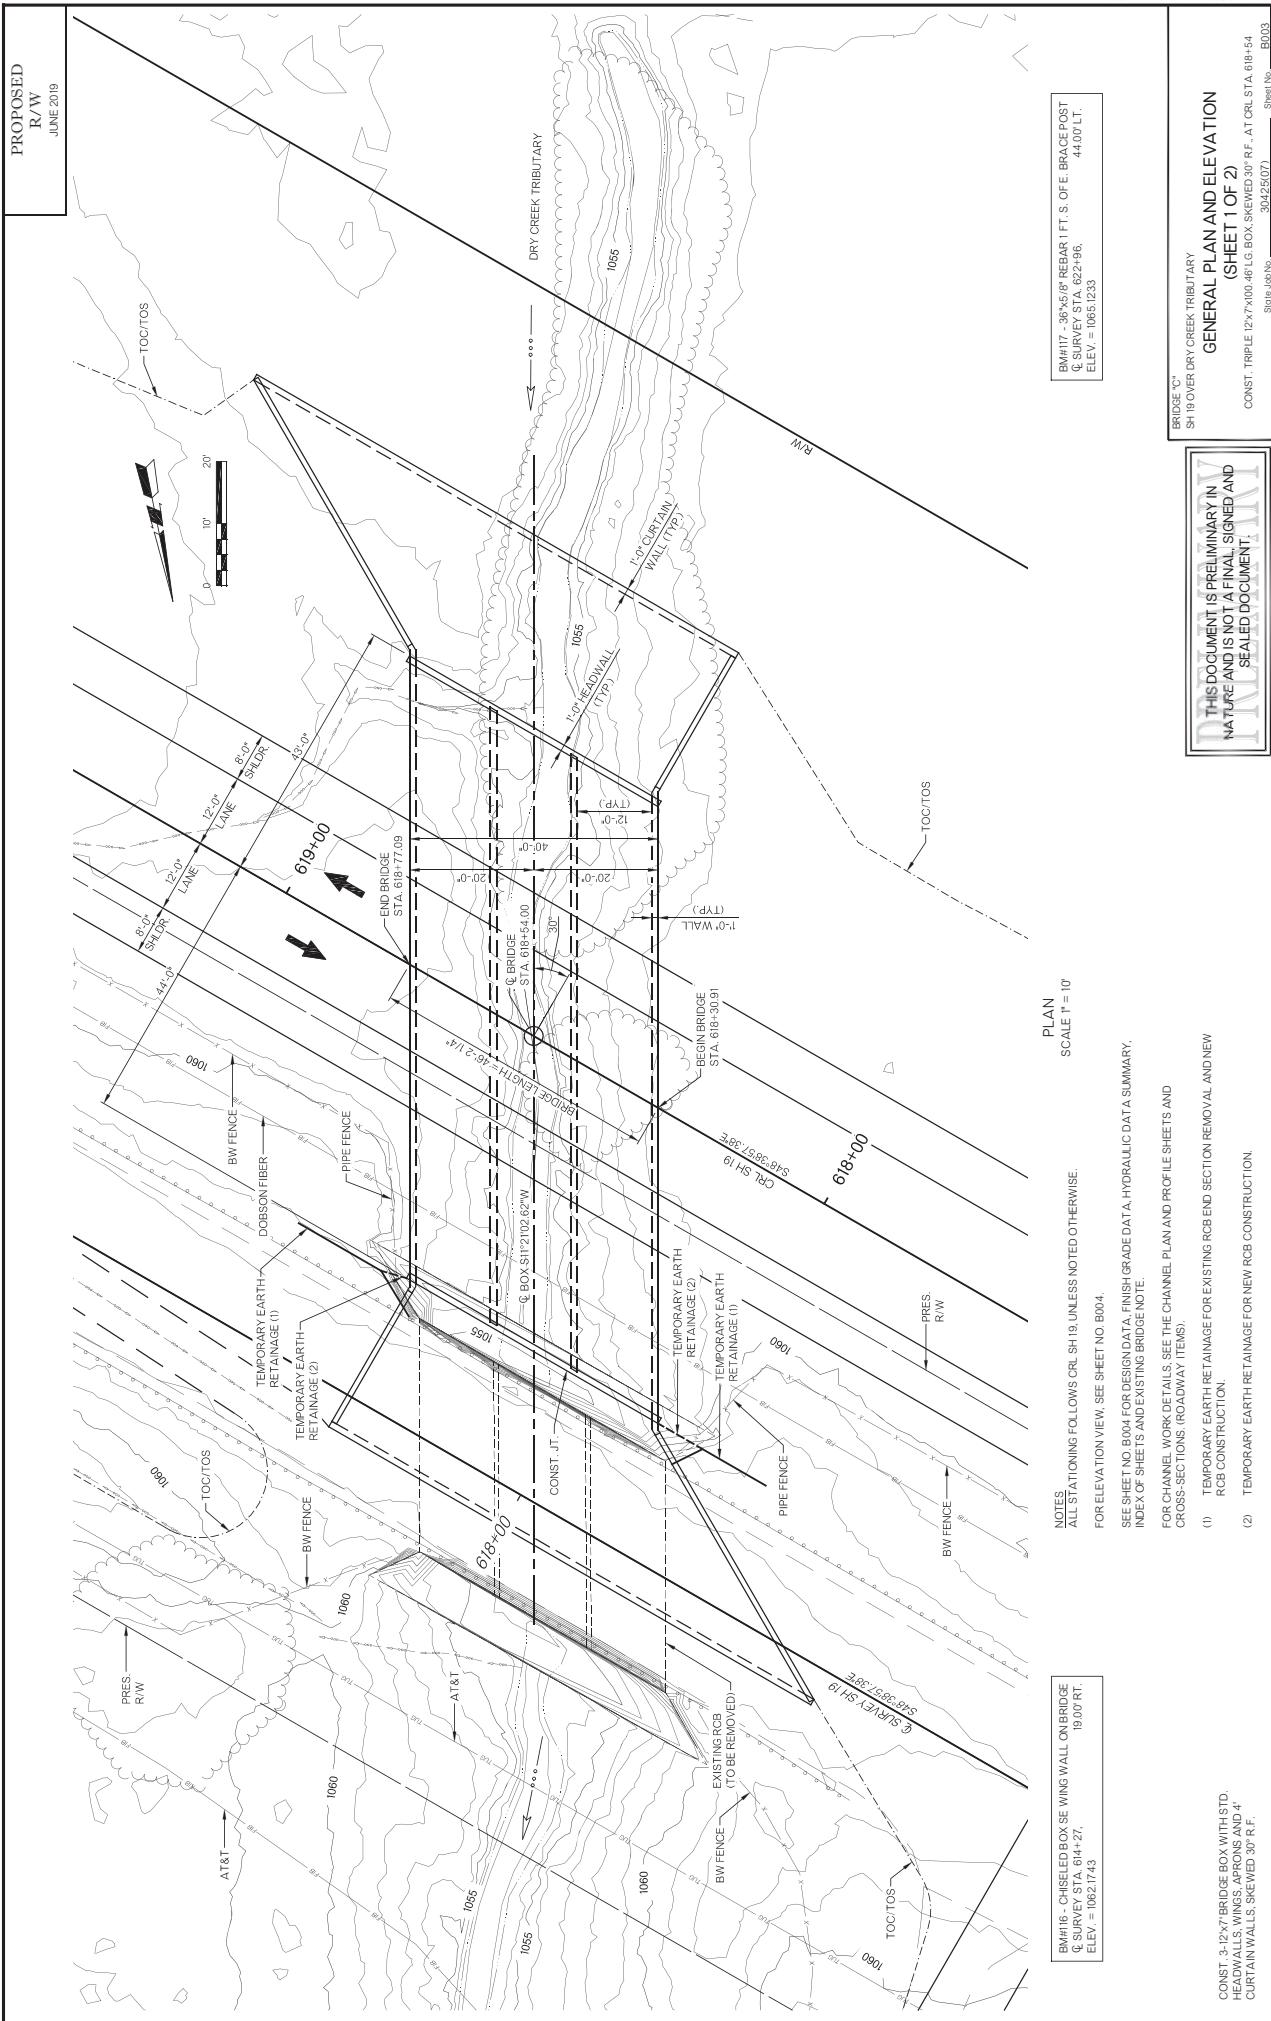

PROPOSED
R/W
JUNE 2019

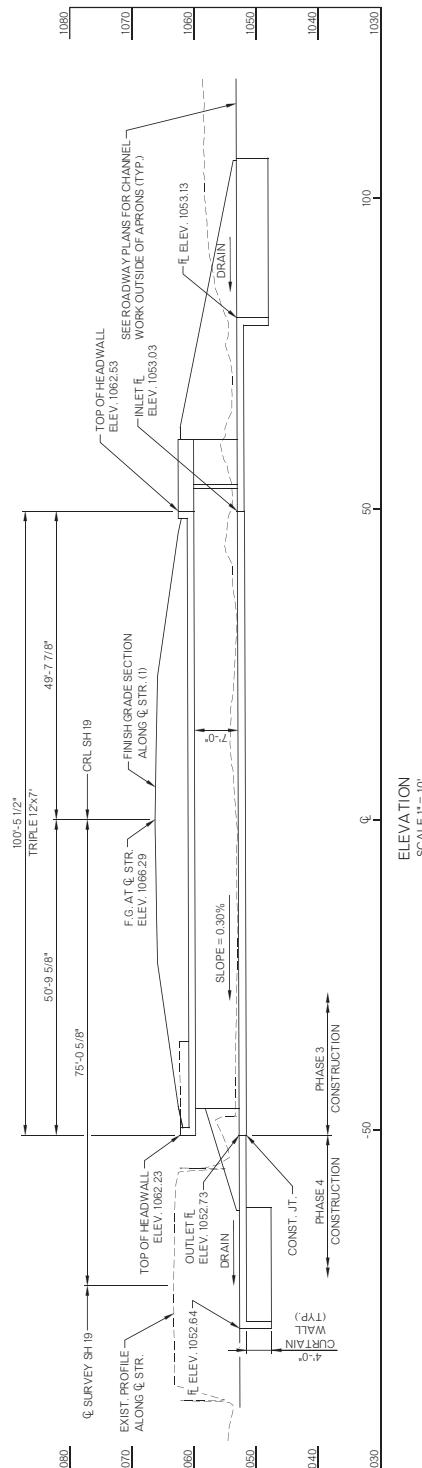

BM#116 - CHISELED BOX SE WING WALL ON BRIDGE
© SURVEY STA. 614+27.
ELEV. = 1062.1743

BM#117 - 36X58" REBAR FT. S. OF E. BRACE POST
© SURVEY STA. 622+96.
ELEV. = 1065.1233

INDEX OF SHEETS (BRIDGE "C")

NO.	DESCRIPTION	TOTAL DA. = 2.99 SQ. MI.	CONTROLLED DA. = 1.56 SQ. MI.	EFFECTIVE DA. = 1.43 SQ. MI.	GENERAL PLAN AND ELEVATION (SHEET 1 OF 2)
B004					GENERAL PLAN AND ELEVATION (SHEET 2 OF 2)

HYDRAULIC DATA - BRIDGE "C"

FREQ.	Q (cfs)	CW(ft)	V (fps)
2	214	1058.64	2.56
5	422	1059.65	2.99
10	603	1060.06	3.17
25	876	1060.64	2.77
50	1087	1061.14	2.68
100	1409	1061.85	2.77
500	2819	1065.47	2.94
RDWY OT > Q500	0	0	0
DETUR OT	0	0	0

- EXISTING BRIDGE NOTE:
THE EXISTING BRIDGE SHALL BE REMOVED IN ACCORDANCE WITH THE NOTES ON SHEET XX.
- (1) SEE ROADWAY PLAN AND PROFILES AND CROSS SECTIONS.



SUMMARY OF QUANTITIES - BRIDGE "C"			
NO.	DESCRIPTION	UNIT	TOTAL
SB1-4-2	UNCLASSIFIED EXCAVATION	CY	XXX
	STRUCTURAL EXCAVATION UNCLASSIFIED	CY	XXX
	TEMPORARY EARTH RETAINAGE	L.SUM	XXX
	CLASS AA CONCRETE	CY	XXX
	REINFORCING STEEL	LB	XXX
	REMOVAL OF EXISTING BRIDGE STRUCTURE	L.SUM	XXX

FINISH GRADE DATA
CRL SH 19
(STATIONS SHOWN ON THE DETAIL ARE ALONG CRL)


CONST. 3-12X7" BRIDGE BOX WITH STD.
HEADWALLS, WINGS, APRONS AND 4'
CURTAIN WALLS, SKewed 30° R.F.,

GENERAL PLAN AND ELEVATION
(SHEET 2 OF 2)
CONST. TRIPLE 12X7X10.46' G. BOX, SKewed 30° R.F., CRL STA. A, 618+54
Sheet Job No. 30425(07) Sheet No. B004

EXISTING BRIDGE NOTE:
THE EXISTING BRIDGE SHALL BE REMOVED IN ACCORDANCE WITH THE NOTES ON SHEET XX.

SH 19
GRADY COUNTY

PROPOSED
R/W
JUNE 2019

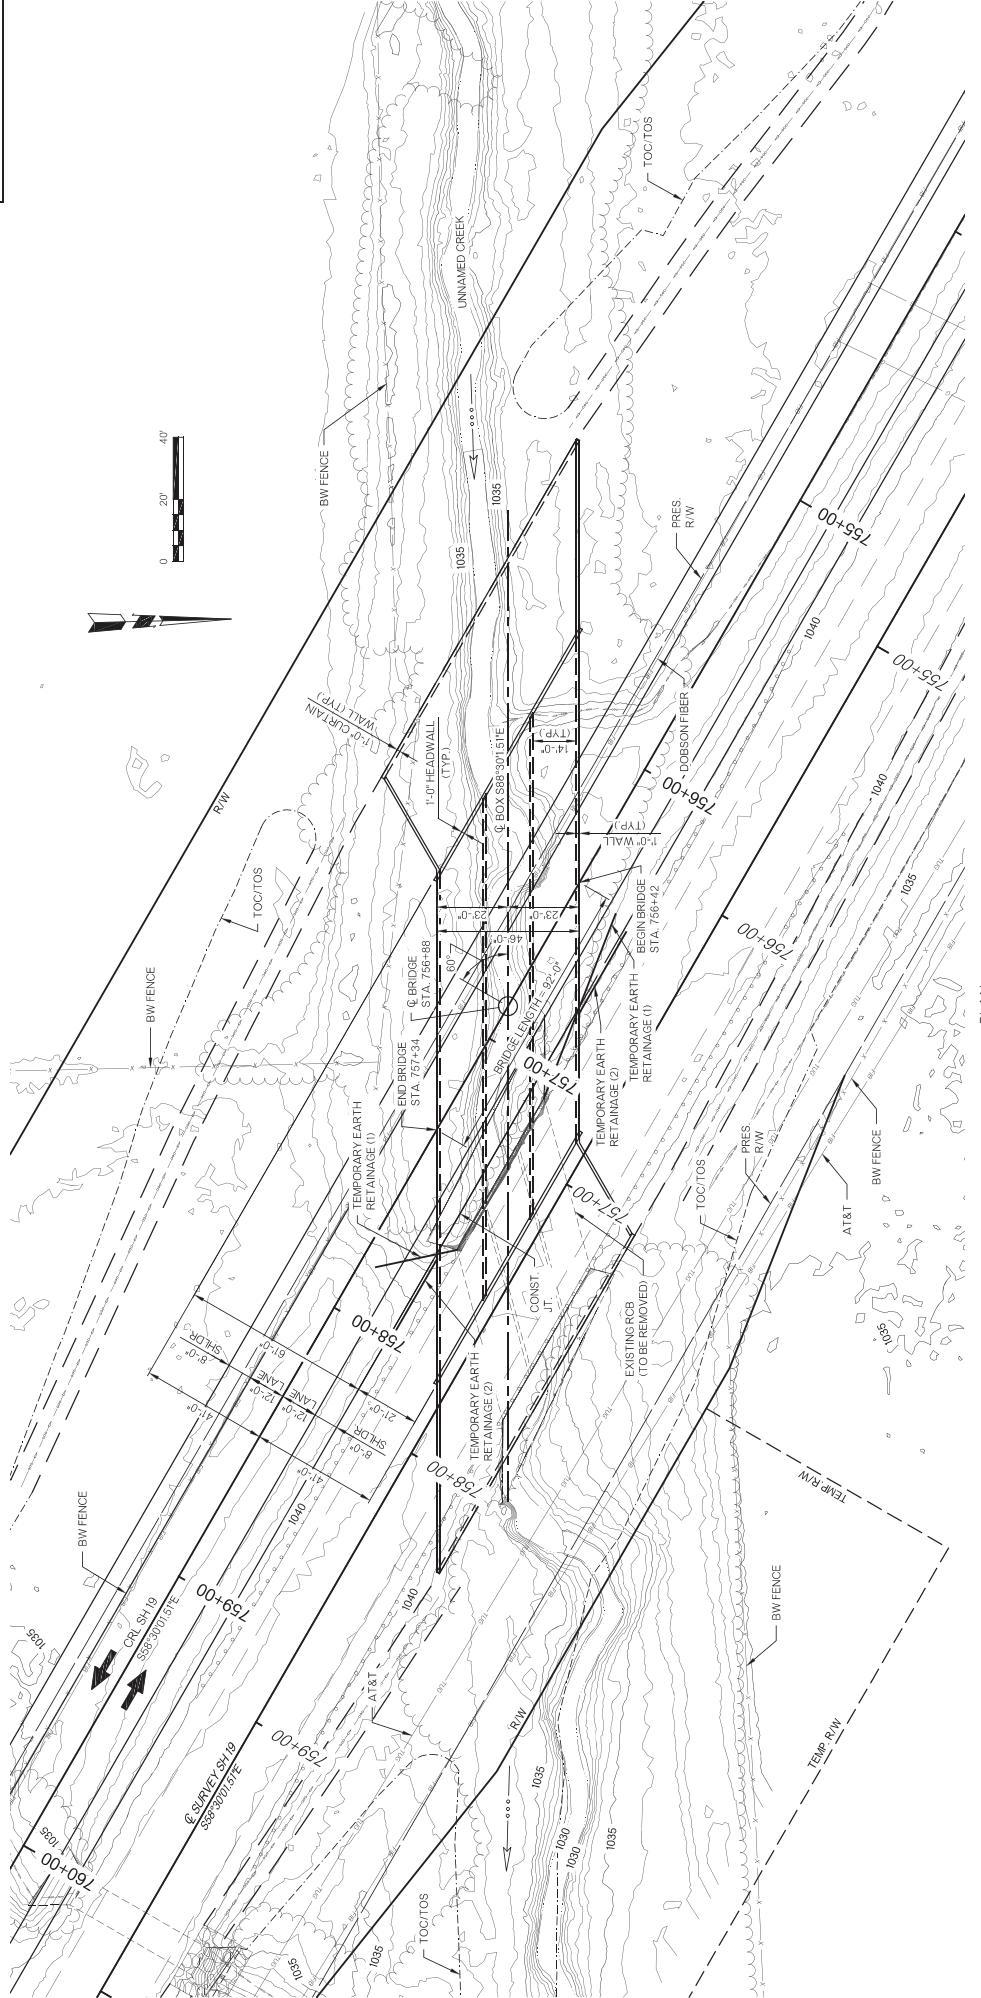

BH4H32, CHISELED BOX ON CENTER OF HEADWALL
26.00 RT.
Q SURVEY STA. 753+25,
ELEV = 1038.7846

BH4H33, CHISELED BOX ON CENTER OF HEADWALL
35.00 RT.
Q SURVEY STA. 754+24,
ELEV = 1038.0733

PLAN
SCALE 1" = 20'


NOTES:
ALL STATIONING FOLLOWS CRL SH19; UNLESS NOTED OTHERWISE.
SEE SHEET NO B006 FOR DESIGN DATA, FINISH GRADE DATA, HYDRAULIC DATA, SUMMARY, INDEX OF SHEETS AND EXISTING BRIDGE NOTE.

- FOR CHANNEL WORK DETAILS, SEE SHEET NO B006.
(1) TEMPORARY EARTH RETAINAGE FOR EXISTING RCB END SECTION REMOVAL AND NEW RCB CONSTRUCTION
(2) TEMPORARY EARTH RETAINAGE FOR NEW RCB CONSTRUCTION

CONST. 3'-11"X8' BRIDGE BOX WITH SP
HEADWALLS, WINGS, APRONS AND 4'
CURTAINWALLS, SKewed 60° L.F.
Site Job No. 30425(07)

GENERAL PLAN AND ELEVATION
(SHEET 1 OF 2)
CONST. TRIPLE 11x8x164 L.C. BOX, SKWED 60° L.F., AT CRL STA. 758+88
Sheet No. B005
B005

PROPOSED
R/W
JUNE 2019

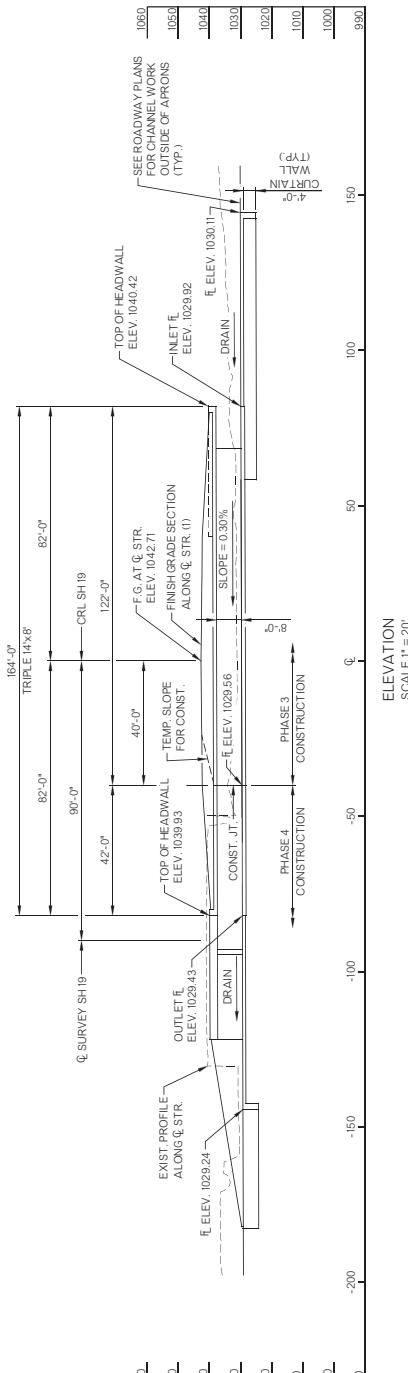


EM#132 - CHISELED BOX ON CENTER OF HEADWALL
© SURVEY STA 733+25.
ELEV. = 1038.7846

EM#133 - CHISELED BOX ON CENTER OF HEADWALL
© SURVEY STA 761+24.
ELEV. = 1038.0733

INDEX OF SHEET(S) BRIDGE "D"

NO. DESCRIPTION
XX PAY QUANTITIES AND GENERAL NOTES
B005 GENERAL PLAN AND ELEVATION (SHEET 1 OF 2)
B006 GENERAL PLAN AND ELEVATION (SHEET 2 OF 2)

HYDRAULIC DATA - BRIDGE "D"

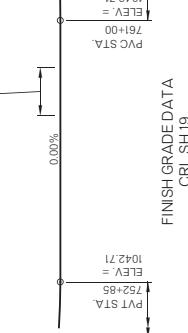

(STATIONS SHOWN ON THE DETAIL ARE ALONG CRL)

NO.	FREQ.	TOTAL D.A. = 2.68 SQ. MI.	CONTROLLED D.A. = 1.42 SQ. MI.	EFFECTIVE D.A. = 1.26 SQ. MI.	Q (cfs)	CW/H (ft)	V (fps)
2	21B	1038.10	1.10				
5	47I	1039.82	1.61				
10	72T	1041.09	2.16				
25	1160	1041.48	3.45				
50	1470	1041.93	4.37				
100	1560	1042.38	5.27				
500	1880	1043.01	5.27				
RDWY OT = Q 147	1670	1042.18	4.87				
DETOUR OT	0	0	0				

CONST. 3-14'x8' BRIDGE BOX WITH SP.
HEADWALLS, WINGS, APRONS AND 4'
CURTAIN WALLS, SKewed 60° LF.

BRIDGE "D"
SH 19 OVER UNNAMED CREEK

GENERAL PLAN AND ELEVATION
(SHEET 2 OF 2)

CONST. TRIPLE 14'x64' LG BOX, SKWED 60° LF, 758+88
Sheet Joining _____ Sheet No. 30425(07) _____ B005

SUMMARY OF QUANTITIES - BRIDGE "D"

DESCRIPTION	UNCLASSIFIED EXCAVATION	STRUCTURAL EXCAVATION UNCLASSIFIED	UNIT	TOTAL
TEMPORARY EARTH RETAINAGE			CY	XXX
CLASS AA CONCRETE			CY	XXX
REINFORCING STEEL			LB	XXX
REMOVAL OF EXISTING BRIDGE STRUCTURE			LSUM	XXX

(1) SEE ROADWAY PLAN AND PROFILES AND CROSS SECTIONS.

DESIGN DATA
(LOAD AND RESISTANCE FACTOR DESIGN)

CLASS "AA" CONCRETE
REINFORCING STEEL
FC = 40000PSI
FY = 60000 PSI
LOADING: H-93 AND OOZ OVERLOAD TRUCK
DESIGN: AASHTO LRFD BRIDGE DESIGN SPECIFICATIONS, 8TH EDITION

THE FOLLOWING STANDARDS SHALL BE REQUIRED:

SB-4-2

NOTES
ALL STATIONING FOLLOWS CRL SH 19 UNLESS NOTED OTHERWISE
THE CONTRACTOR SHALL MAINTAIN DRAINAGE AT ALL TIMES DURING
CONSTRUCTION
FOR CHANNEL WORK DETAILS SEE THE CHANNEL PLAN AND PROFILE SHEETS AND
CROSS-SECTIONS, ROADWAY ITM'S.



EXISTING BRIDGE NOTE:
THE EXISTING BRIDGE SHALL BE REMOVED IN ACCORDANCE WITH THE NOTES ON SHEET XX.



GENERAL PLAN AND ELEVATION
(SHEET 2 OF 2)

CONST. TRIPLE 14'x64' LG BOX, SKWED 60° LF, 758+88
Sheet Joining _____ Sheet No. 30425(07) _____ B005

